

### LOCUS MAP



# PROPOSED 45 KENT STREET RESIDENCES

SD SET: 04-12-2017

<u>CLIENT</u> FRANK SCHIFANO

ARCHITECT
KHALSA DESIGN INC.
17 IVALOO STREET, SUITE 400
SOMERVILLE, MA 02143
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PROJECT NAME

45 KENTSTREET

PROJECT ADDRESS

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SOMERVILLE, MA

CLIENT

FRANK SCHIFANO

ARCHITECT

5 / 6

KHALSA

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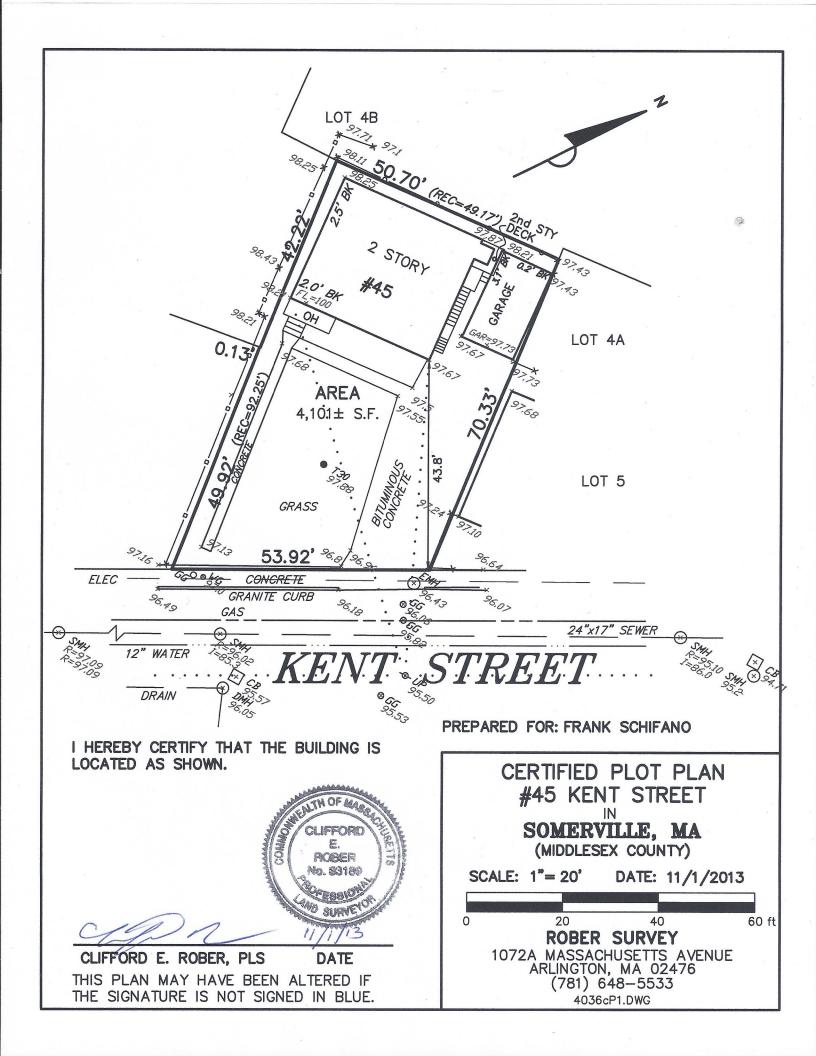
REGISTRATION



Project nu	ımber	14023
Date		04/12/2017
Drawn by		CC
Checked	by	JSK
Scale		
REVISI	ONS	
No.	Description	Date

**Cover Sheet** 

**A-000**45 KENTSTREET



04/12/2017

As indicated

Date

JSK

Zoning Plan	
4-010	
45 KENTSTREET	

ZONING CHART				
ZONE : RC	REQUIRED	EXISTING	PROPOSED	REMARKS
LOT AREA, MIN S.F./DU	7,500 S.F.	4,101 S.F. +/-	4,101 S.F. +/-	PRE-EXISTING/ NO CHANGE
MIN. LOT AREA / DU	875 S.F.	2DU= 2,050 S.F./ DU	3 DU= 1,367 S.F./ DU	COMPLIES
MAX. GROUND	70% (2,870 S.F. MAX.)	30% (1,230 S.F. MAX.)	34% (1,395 S.F. MAX.)	DOES NOT COMPLY
COVERAGE MIN. LANDSCAPED AREA	25% (1,025 S.F. MIN.)	42% (1,748 S.F. MIN.)	39% (1,593 S.F. MIN.)	COMPLIES
MAX. FAR	2.0 (8,202 S.F. MAX)	0.41 (1,681 S.F. MAX)	0.78 (3,184 S.F. MAX)	COMPLIES
MAX HEIGHT	40' - 0" / 3 STORIES	22' - 6" / 2 STORIES	32' - 8" / 3 STORIES	COMPLIES
MIN. FRONT YARD	15' - 0"	43.8'	27.3'	COMPLIES

SECTION 8.6; 5. Front yard: If the average front yard depth of two (2) or more existing buildings on each side of a lot within one hundred (100) feet and within the district and same block, uninterrupted by an intersection, is less than the required front yard, the average of such existing front yard depths may be the required front yard depth for buildings of three (3) stories or less, but in no case may the front yard depth be less than ten (10) feet.

MIN. SIDE YARD	10'-0" SUM 20'-0"	2'-0" (L), 11'-1" (R) TO DECK	1'-9" (L), 10'-8.5" (R) TO DEC	KDOES NOT COMPLY (L) COMPLIES (R)
MIN REAR YARD (FOOTNOTE 13)	18'-3" FOOTNOTE 13 (20'-(100'-93' X 3"	2' - 7" ))	2' - 7"	PRE-EXIST./ NO CHANGE
ACCESSORY BLDG. FRONT SIDE REAR	15' - 0" 3'-0" 3'-0"	47' - 0" 38'-6" (L), 0'-0" (R) 3'-3"	47' - 0" 38'-6" (L), 0'-0" (R) 3'-3"	COMPLIES/ NO CHANGE COMPLIES/ NO CHANGE (L), PRE-EXIST/ NO CHANGE (R) COMPLIES/ NO CHANGE
MIN. FRONTAGE	50' - 0"	53.92'	53.92'	COMPLIES/ NO CHANGE
MIN. PERVIOUS AREA	30% OF LOT (1,230 S.F.	42% (1,748 S.F. MIN.)	39% (1,593 S.F. MIN.)	COMPLIES
PARKING	MIN.) EXISTING REQ 3 SPACES PROPOSED REQ 4.5 SPACES	2 SPACES (TANDEM)	3 SPACES ( 2 ARE TANDEM	COMPLIES

Section 9.5. - Number of Parking Spaces.

2.) Special Residential Conversions:


a.Existing 1 and 2 family residences converting to 2 or 3 family residences shall provide one (1) parking space per additional (e.g. newly created) dwelling unit. Also note that the provisions of Section 9.4 as to nonconformity with respect to parking are likely to apply in many instances.


EXAMPLE: A single family home is converting to a 2 family residence. One (1) space is required for each new dwelling unit created in the conversion. If the single-family home is converting to a 3 family residence, then two (2) parking spaces are required for the conversion — one (1) for each new unit.


Note that this is the parking required for the newly converted unit(s) and is additional parking above what is required for the existing site. However, if the existing lot is nonconforming with respect to parking, then please refer to the special considerations under Section 9.4.1.Section 9.5. - Number of Parking Spaces.


FOOTNOTES:
13. Reduction of rear yards for shallow lots: For each foot by which a lot is less than one hundred (100) feet deep on the effective date of this Ordinance, three (3) inches may be deducted from the required depth of the rear yard, provided that no rear yard shall be less than ten (10) feet.

Area Schedule (FAR)				
Level	Name	Area		
First Floor Level	FAR	901 SF		
Second Floor Level	FAR	869 SF		
Existing Roof/ Third Floor Level	FAR	869 SF		
Basement	FAR	546 SF		
Grand total		3184 SF		

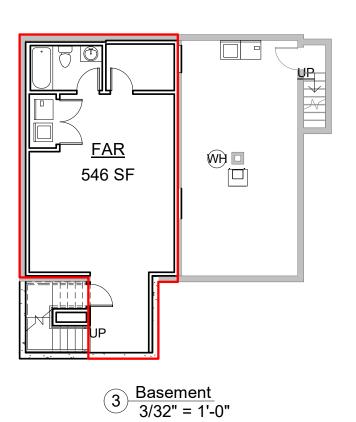

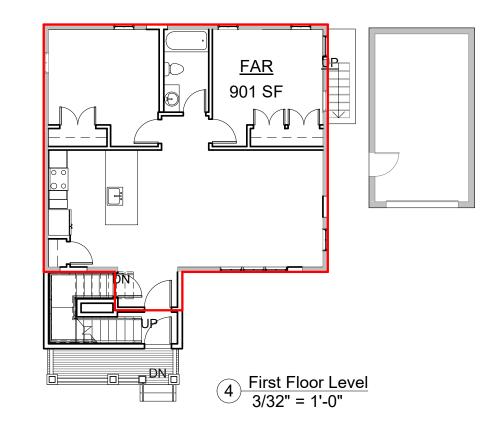

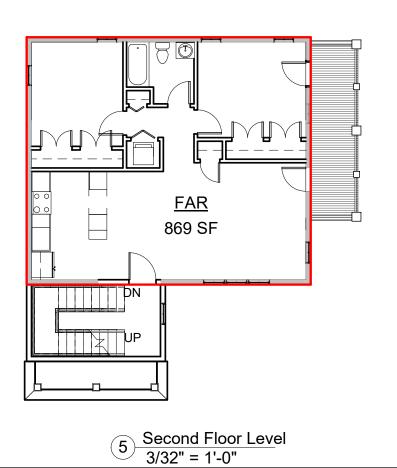

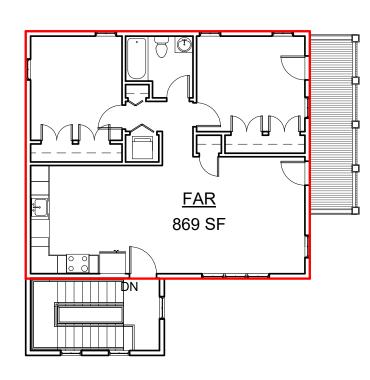

6 Existing Roof/ Third Floor Level 3/32" = 1'-0"



This plan is for informational and illustrative purposes only.

The preparer of this plan makes no claim to its accuracy. This plan shall not be used or relied upon in any circumstance. A certified Land Surveyor shall provide an official certified plot plan.

Zon

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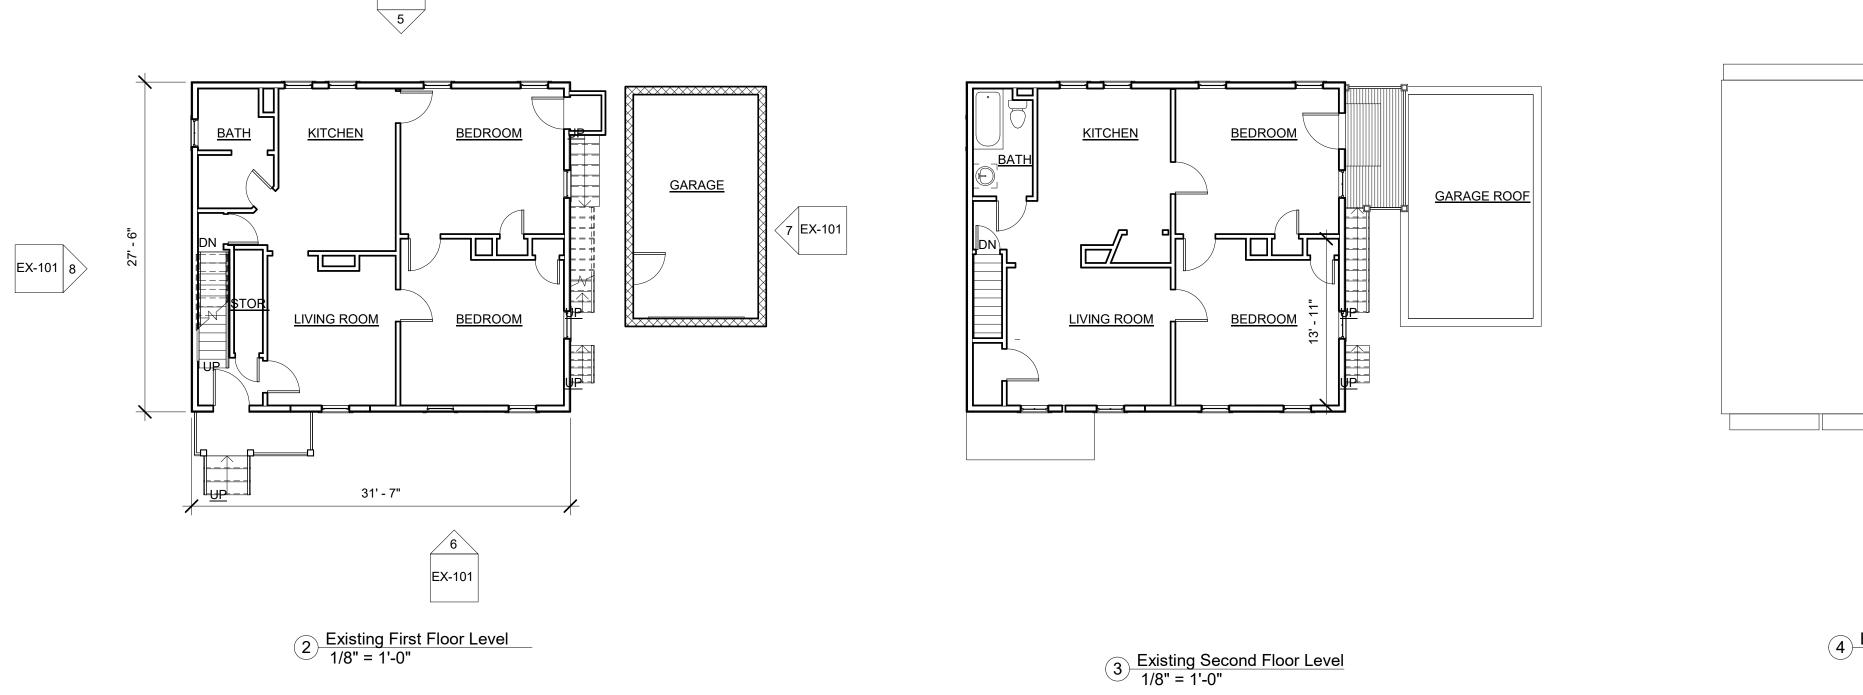
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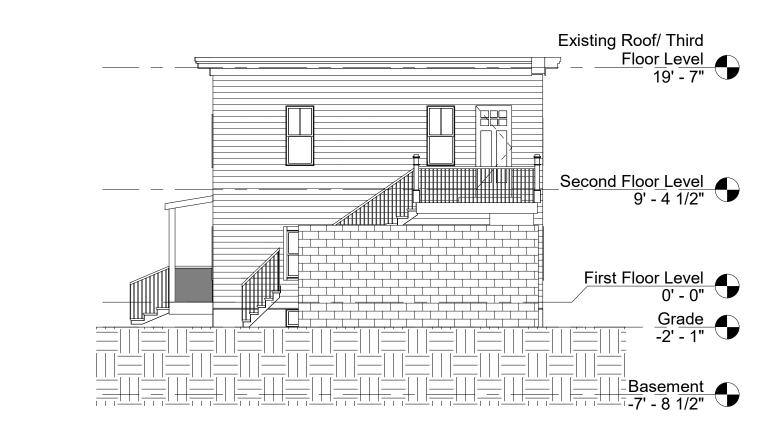
Existing Roof/ Third
Floor Level
19' - 7"

Second Floor Level
9' - 4 1/2"


First Floor Level 0' - 0"


Basement -7' -8 1/2"

Grade -2' -\_1"



7 Existing Right Elevation
1/8" = 1'-0"

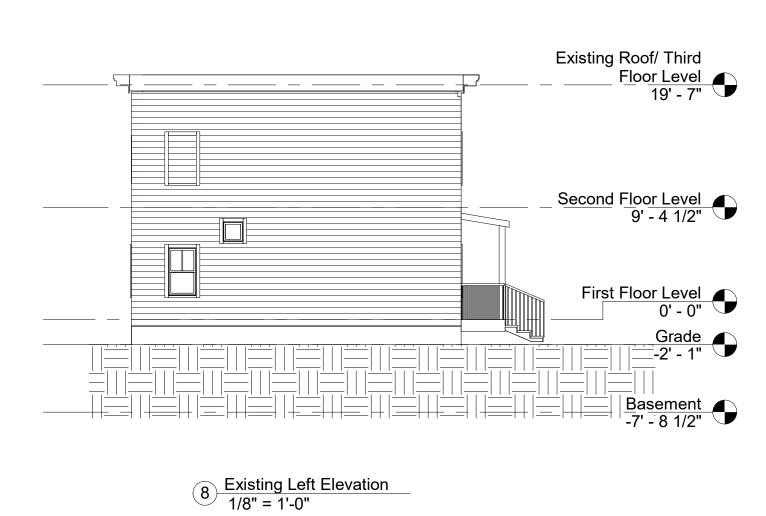

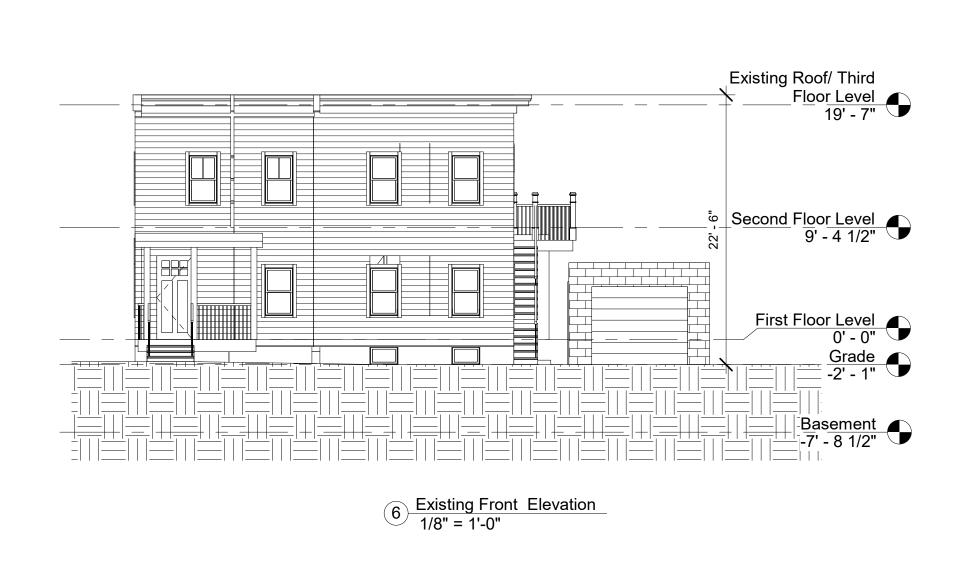

5 Existing Rear Elevation
1/8" = 1'-0"

EX-101

<u>LAUNDRY</u>

MECH. /STORAGE

MECH. /STORAGE

1 Existing Basement 1/8" = 1'-0"

Existing Conditions

PROJECT NAME

**EX-101** 45 KENTSTREET

14023

04/12/2017

PS JSK 1/8" = 1'-0"

Date



45 KENT STREET,

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14023 04/12/2017 PS/ TC JSK 1/4" = 1'-0" Date Description

Proposed Floor Plans





### EXISTING HARRISON STREET VIEW



PROPOSED HARRISON STREET VIEW

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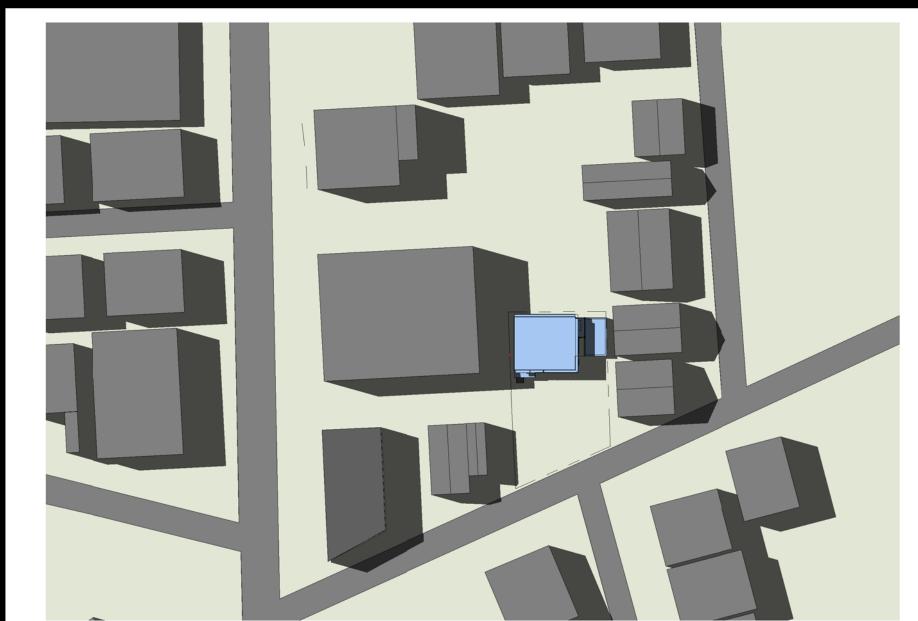
Street Views





### NOON (12 AM-1 PM)





## AFTERNOON (3-4 PM)



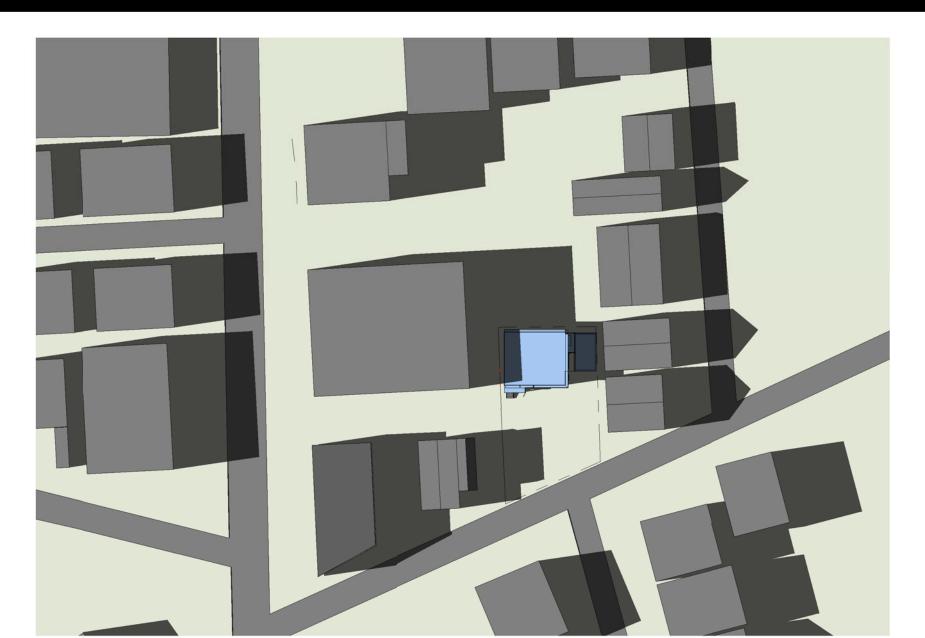

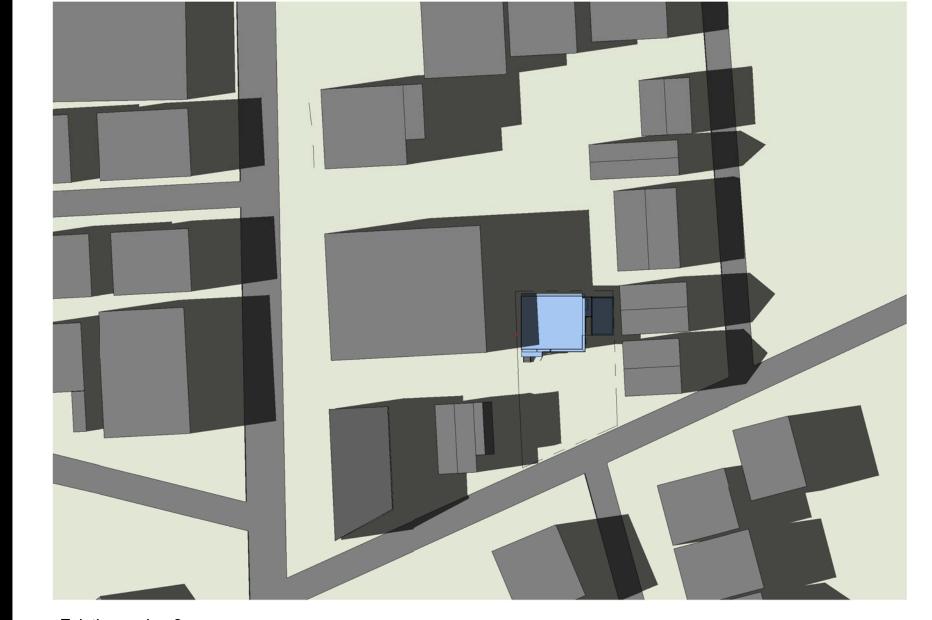

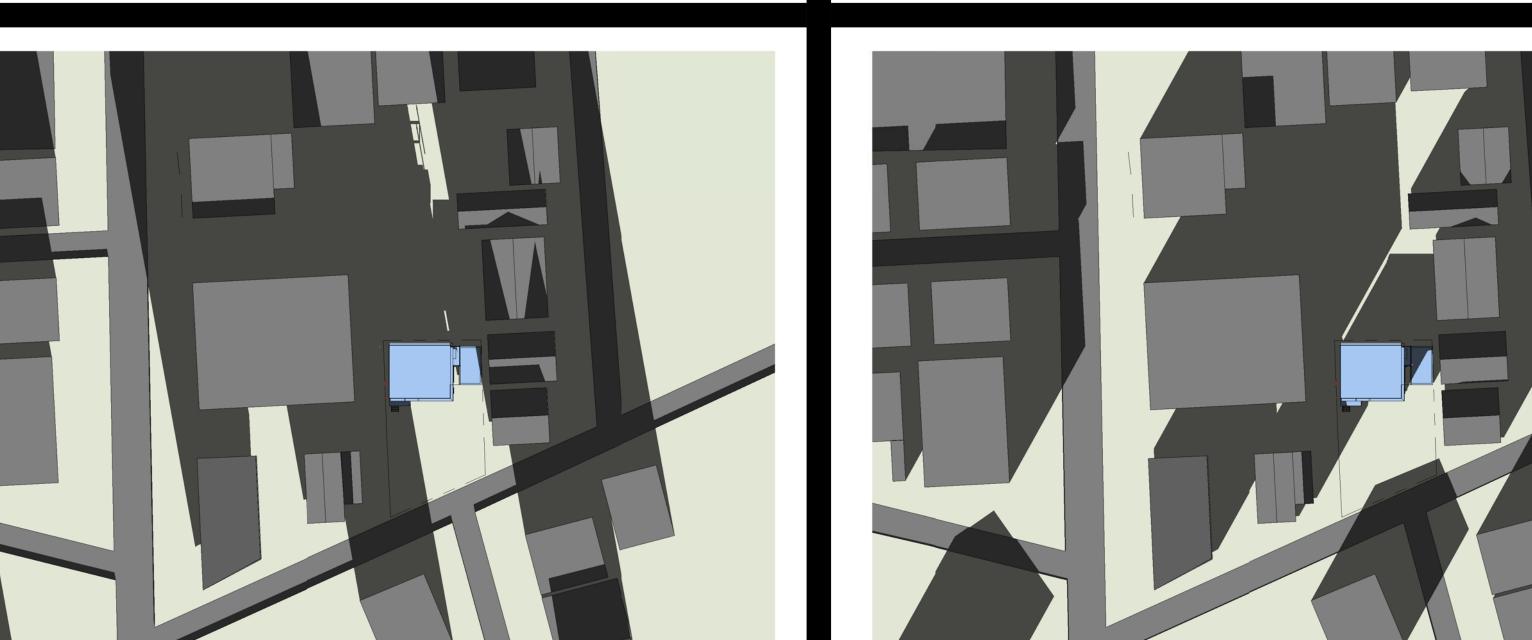

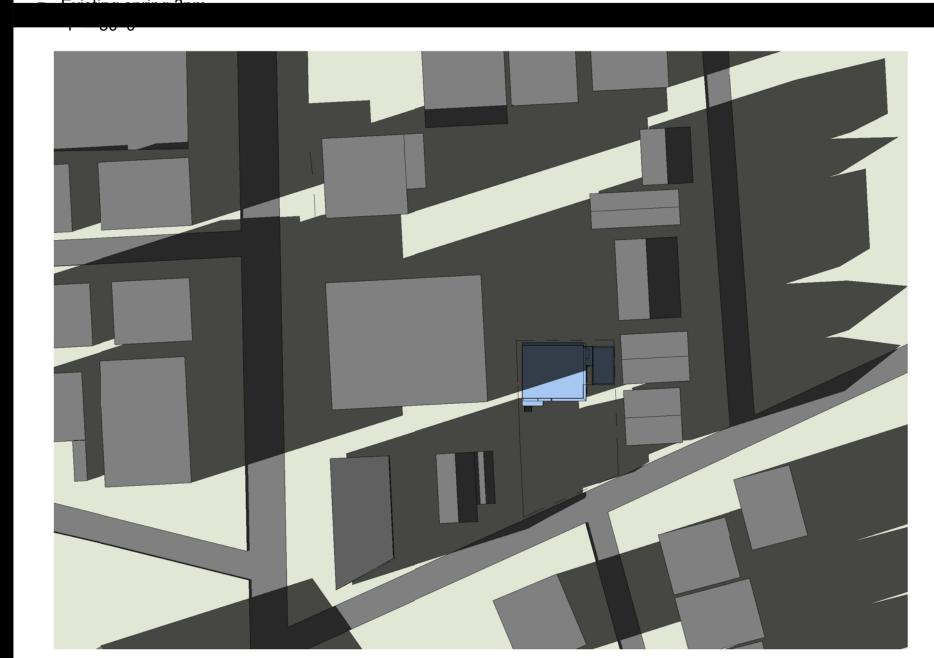

PROJECT NAME


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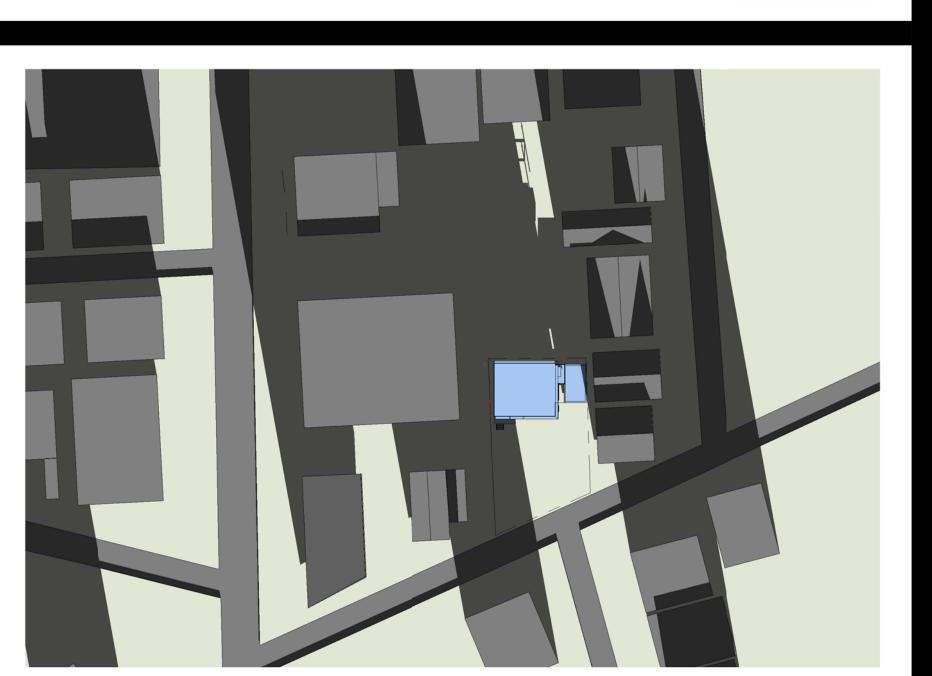
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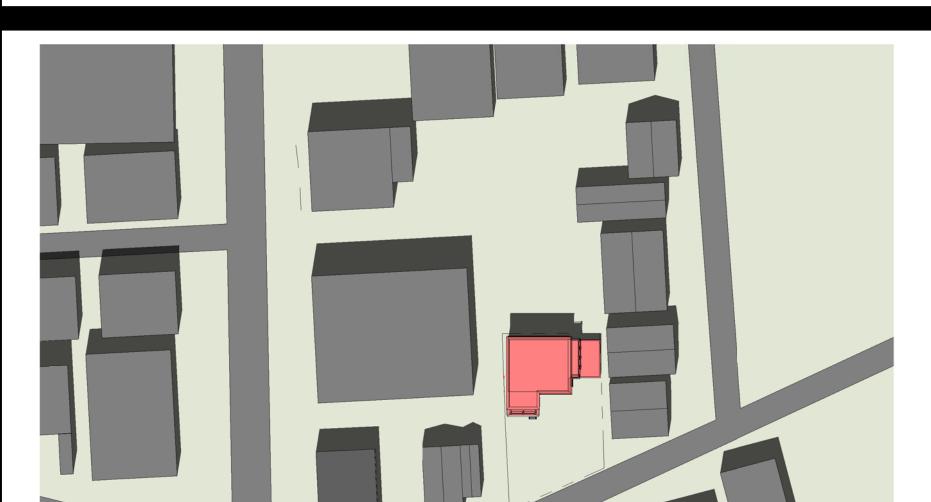
Existing Shadow Study

45 KENTSTREET



MORNING (9-10 AM)

### NOON (12 AM-1 PM)

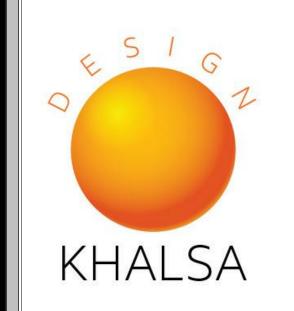


# AFTERNOON (3-4 PM)










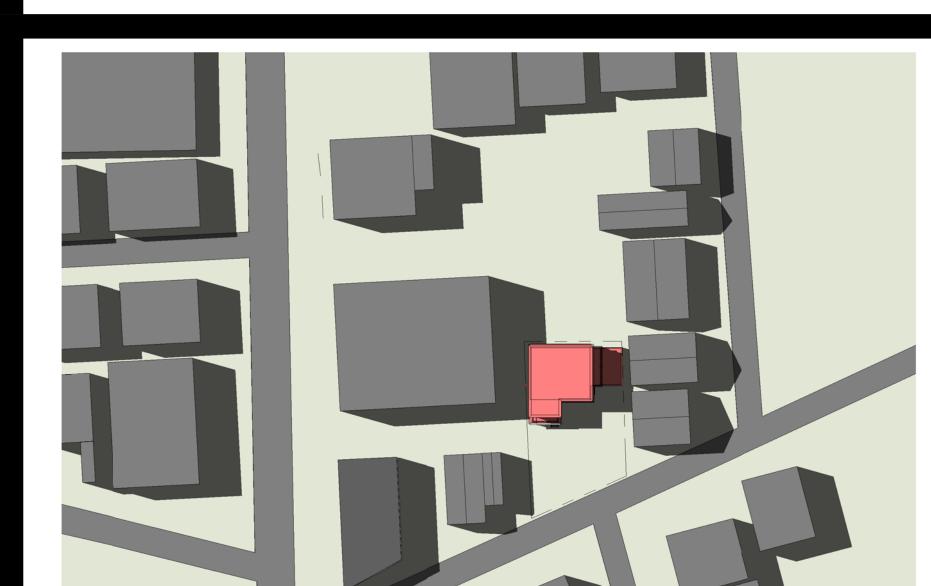

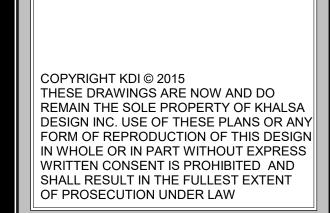

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Proposed Shadow Study

AV-3 45 KENTSTREET



MORNING (9-10 AM)

